


- NOTES**
1. ALL MEASUREMENTS ARE IN MILLIMETERS UNLESS NOTED OTHERWISE.
  2. ALL LEVELS ARE IN METERS ABOVE ORDINANCE DATUM (MOD), UNLESS NOTED OTHERWISE.
  3. ANY LOCATIONS OF EXISTING SERVICES TO BE CONFIRMED ON SITE.
  4. THE DART+ COASTAL PROJECT IS POSITIONED ACCORDING TO THE IRISH TRANSVERSE MERCATOR (ITM) COORDINATE SYSTEM.

- LEGEND**
- PROPOSED ELEMENTS
  - EXISTING ELEMENTS
  - EXISTING ELEMENTS TO BE REMOVED
  - DEVELOPMENT BOUNDARY
  - PROPOSED WALKWAY

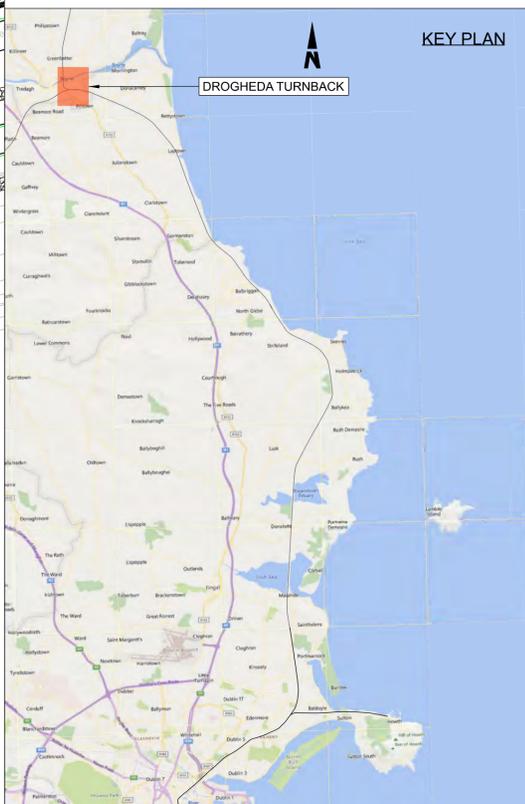

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Rev	Date	Drn	Chk'd	App'd	Description
P01	20/10/2023	MV	EJ	DB	PLANNING ISSUE


Date	Scale	Drawn	Checked	Approved
01/06/2023	1:200 @ A1 1:400 @ A3	AC	EJ	DB
Project Code	Originator Code	QMS Code		
D+WP56	ARP	280275-00		

Project Title	DART+ COASTAL NORTH			
Drawing Title	DROGHEDA STATION TURNBACK PLATFORM CAR PARK LAYOUT			
Drawing File Name	Sheet Number	Status	Rev	
D+WP56-ARP-P4-NL-DR-RO-001314	01 of 01	S3	P01	

DO NOT SCALE USE FIGURED DIMENSIONS ONLY


**NOTES**

1. ALL MEASUREMENTS ARE IN METRES UNLESS NOTED OTHERWISE.
2. ALL LEVELS ARE IN METRES ORDNANCE DATUM (MOD), UNLESS NOTED OTHERWISE.
3. ANY LOCATIONS OF EXISTING SERVICES/UTILITIES SHOULD BE CONFIRMED ON SITE.
4. THE DART+ COASTAL PROJECT IS POSITIONED ACCORDING TO THE IRISH TRANSVERSE MERCATOR (ITM) COORDINATE SYSTEM.

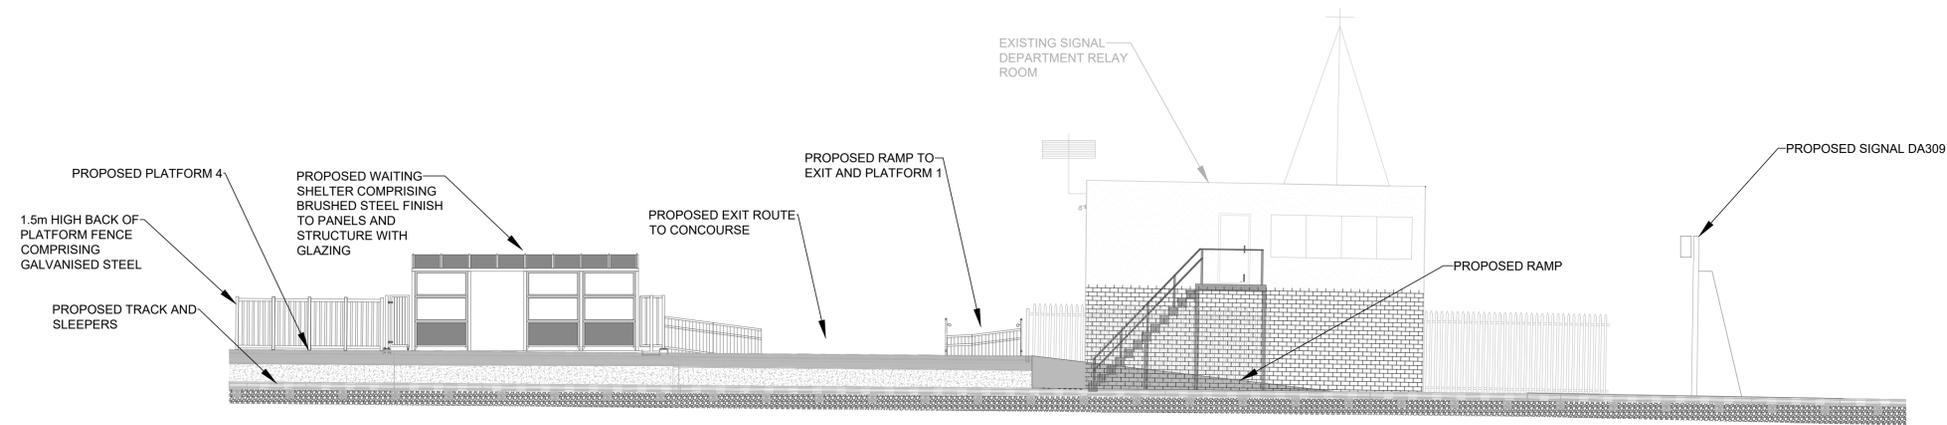

**ELEVATION ON PLATFORM AND SHELTER**

1:100 @ A1

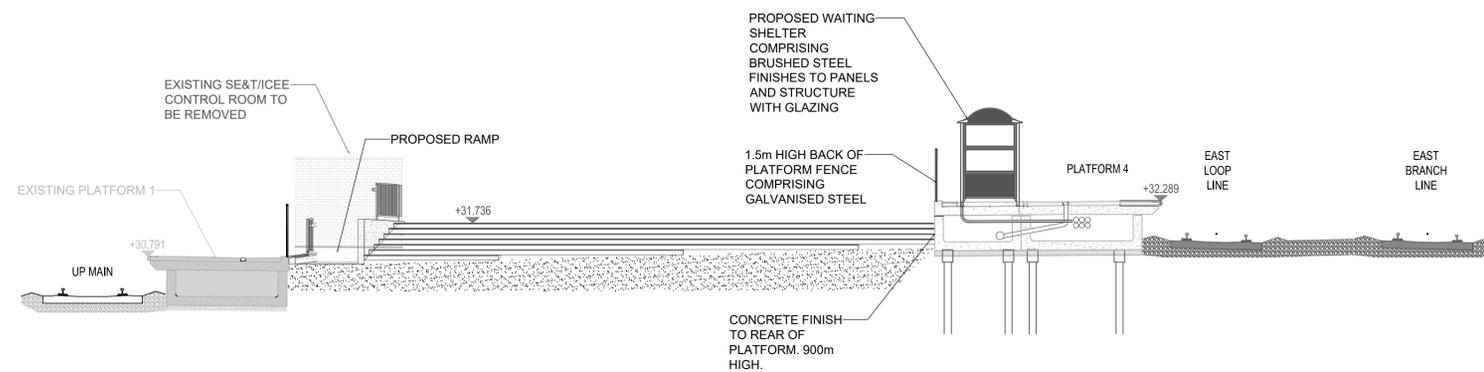

**ELEVATION ON CONCOURSE**

1:100 @ A1

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Rev	Date	Drn	Chk'd	App'd	Description
P01	20/10/2023	MV	EJ	DB	FOR REVIEW AND COMMENT



Client <b>Iarnród Éireann Irish Rail</b>		Engineering Designer <b>ARUP</b>		
Date 20/10/2023	Scale SHOWN @ A1 SHOWN @ A3	Drawn MV	Checked EJ	Approved DB
Project Code D+WP56	Originator Code ARP	QMS Code 280275-00		

Project Title <b>DART+ COASTAL NORTH</b>				
Drawing Title DROGHEDA PLATFORM ELEVATIONS				
Drawing File Name D+WP56-ARP-P4-NL-DR-RO-001315	Sheet Number 01 of 01	Status S3	Rev P01	

DO NOT SCALE USE FIGURED DIMENSIONS ONLY

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**NOTES**

- DO NOT SCALE FROM THIS DRAWING.
- REFERENCE TO BE MADE TO THE PERMANENT WAY DESIGN, SIGNALLING STUDY AND OLE STUDY D+WP56-ARD-P3-NL-RP-SL-000001 AND D+WP56-ARP-P3-NL-RP-PW-000008.
- LOCATION OF ALL BURIED SERVICES TO BE CONFIRMED PRIOR TO CONSTRUCTION. ANY DISCREPANCIES TO BE HIGHLIGHTED TO THE DESIGN ENGINEER.
- ALL DIMENSIONS ARE IN METRES, UNLESS OTHERWISE STATED.
- ALL CHAINAGES ARE IN KILOMETRES.
- DRAWING TO BE PRINTED IN COLOUR.
- ALL LEVELS ARE IN METRES ORDNANCE DATUM (mOD) UNLESS OTHERWISE STATED.
- THE DART+ COASTAL NORTH PROJECT IS POSITIONED ACCORDING TO THE IRISH TRANSVERSE MERCATOR (ITM) COORDINATE SYSTEM.

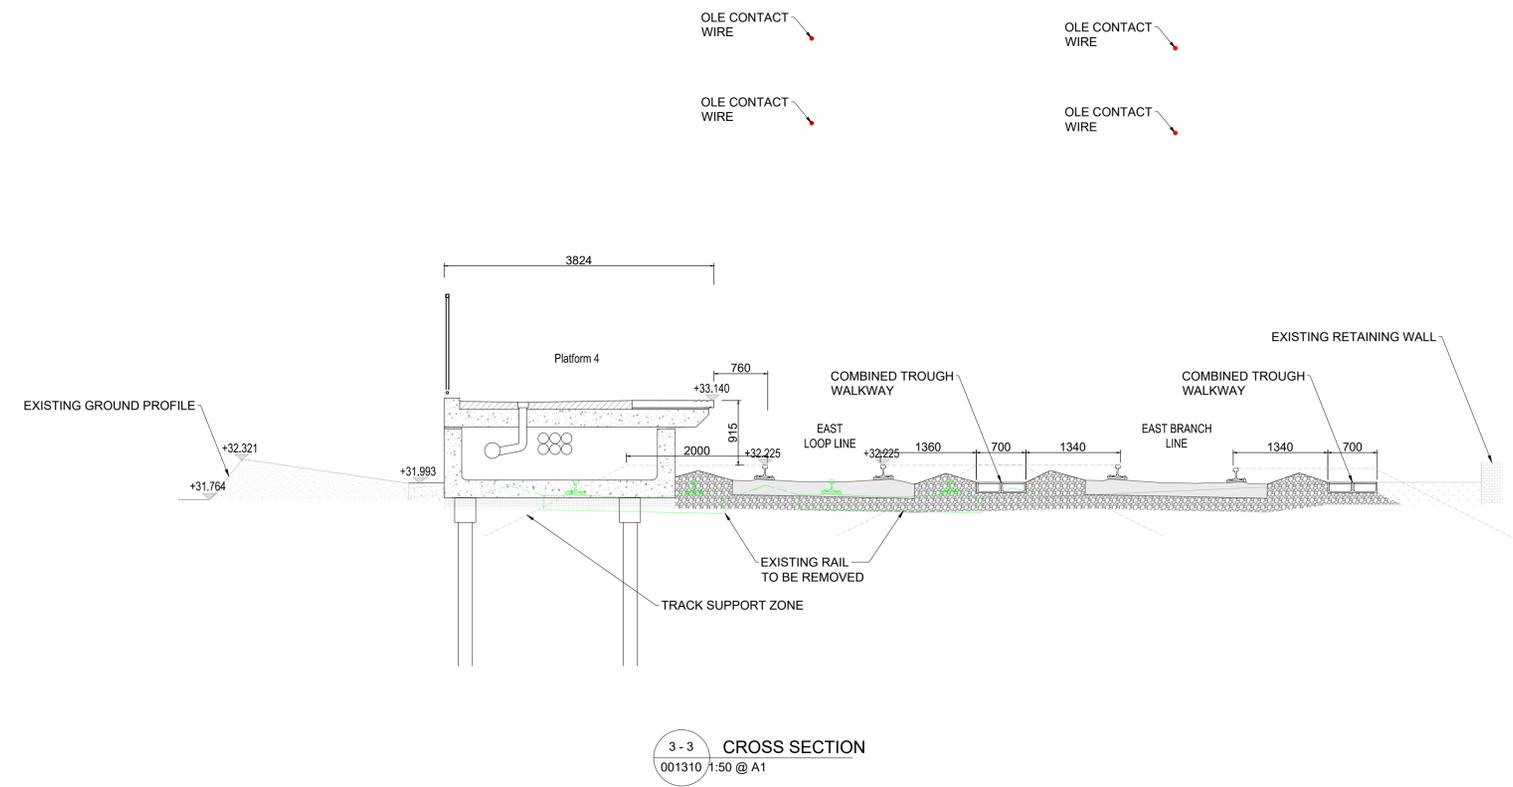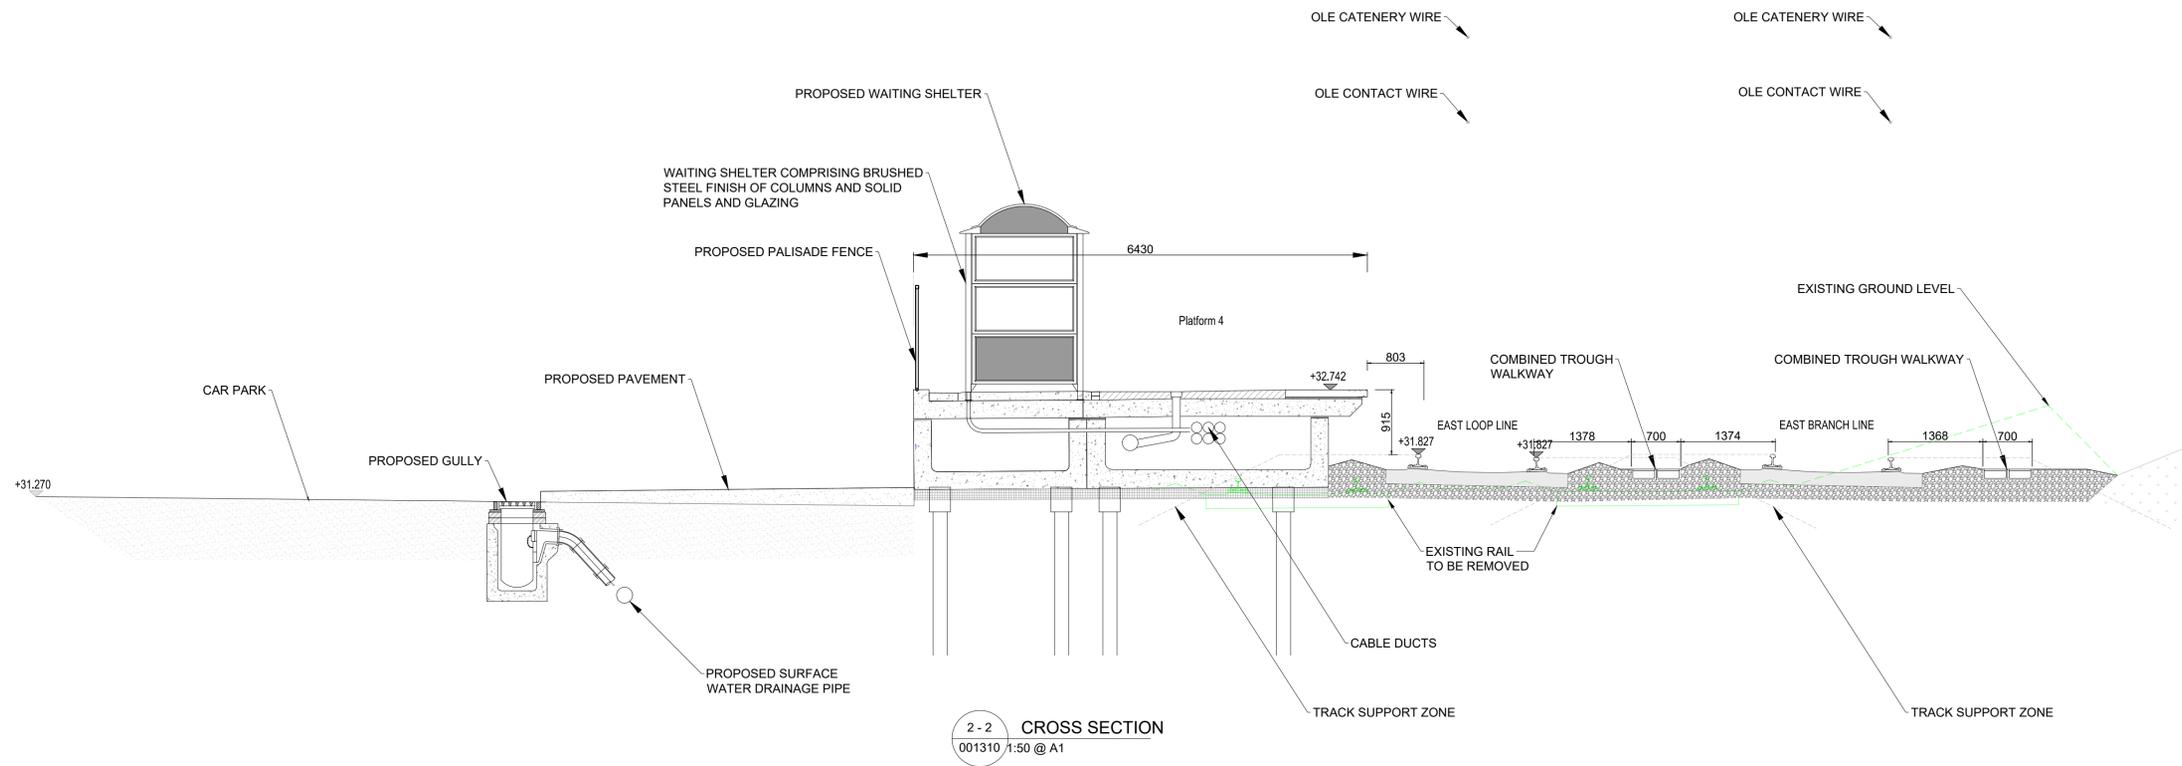**LEGEND**

- EXISTING ELEMENTS
- PROPOSED ELEMENTS
- ELEMENTS TO BE REMOVED

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Rev	Date	Drn	Chk'd	App'd	Description
P01	10/11/2023	SF	EJ	CC	PLANNING ISSUE

Client: **Iarnród Éireann Irish Rail**

Engineering Designer: **ARUP**

Date: 10/11/2023 | Scale: SHOWN @ A1, SHOWN @ A3




Project Code: D+WP56 | Originator Code: ARP | QMS Code: 280275-00

Drawn: SF | Checked: EJ | Approved: CC



Project Title: <b>DART+ COASTAL NORTH</b>			
Drawing Title: <b>DROGHEDA PLATFORM CROSS SECTIONS</b>			
Drawing File Name: D+WP56-ARP-P4-NL-DR-RO-001317	Sheet Number: 02 of 02	Status: <b>S3</b>	Rev: <b>P01</b>

DO NOT SCALE USE FIGURED DIMENSIONS ONLY

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- NOTES**
1. ALL DIMENSIONS ARE SHOWN IN MILLIMETERS UNLESS NOTED OTHERWISE.
  2. ALL LEVELS ARE SHOWN IN METERS ABOVE ORDINANCE DATUM.
  3. DO NOT SCALE FROM THIS DRAWING.
  4. PROPOSED AND EXISTING OVERHEAD LINE EQUIPMENT (OHLE) IS NOT SHOWN IN PLAN OR ELEVATION.
  5. REFER TO BOOK 7 LINEAR WORKS PLANS FOR OHLE AND LINESIDE CIVILS ELEMENTS SHOWN IN PLAN.

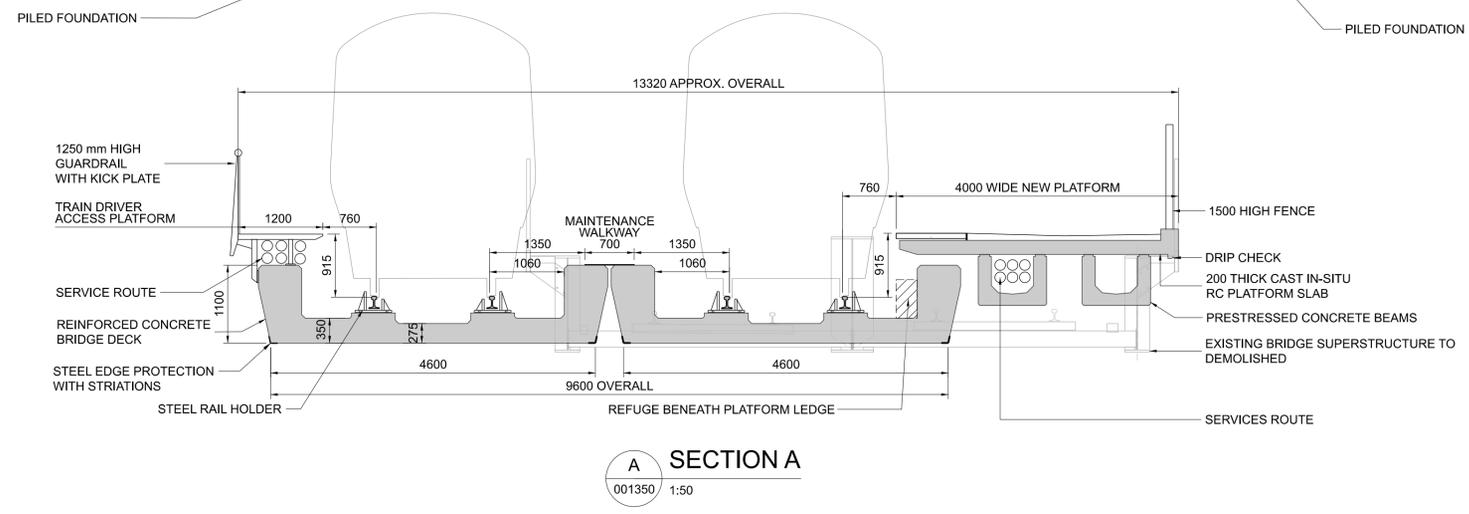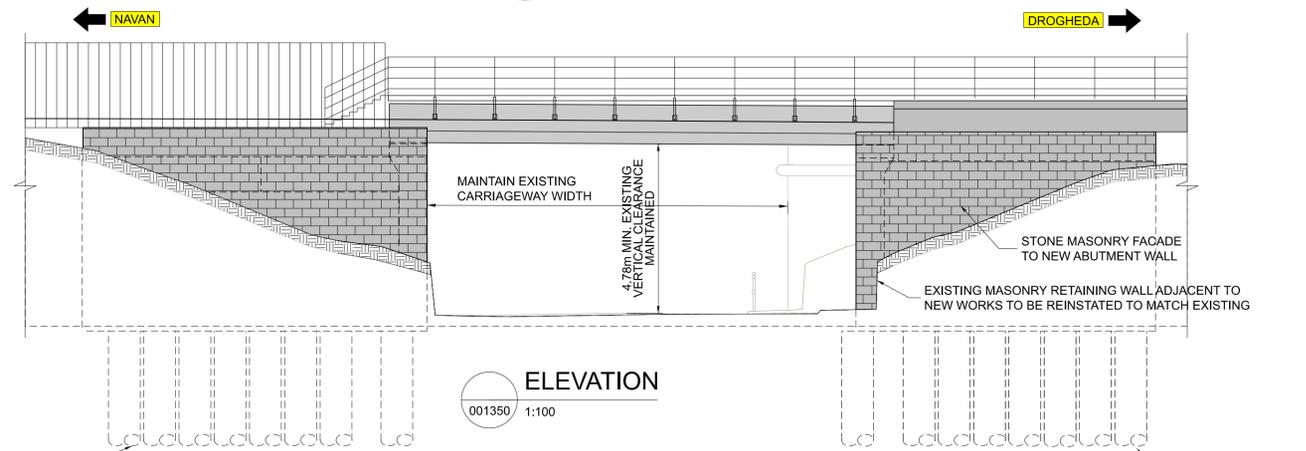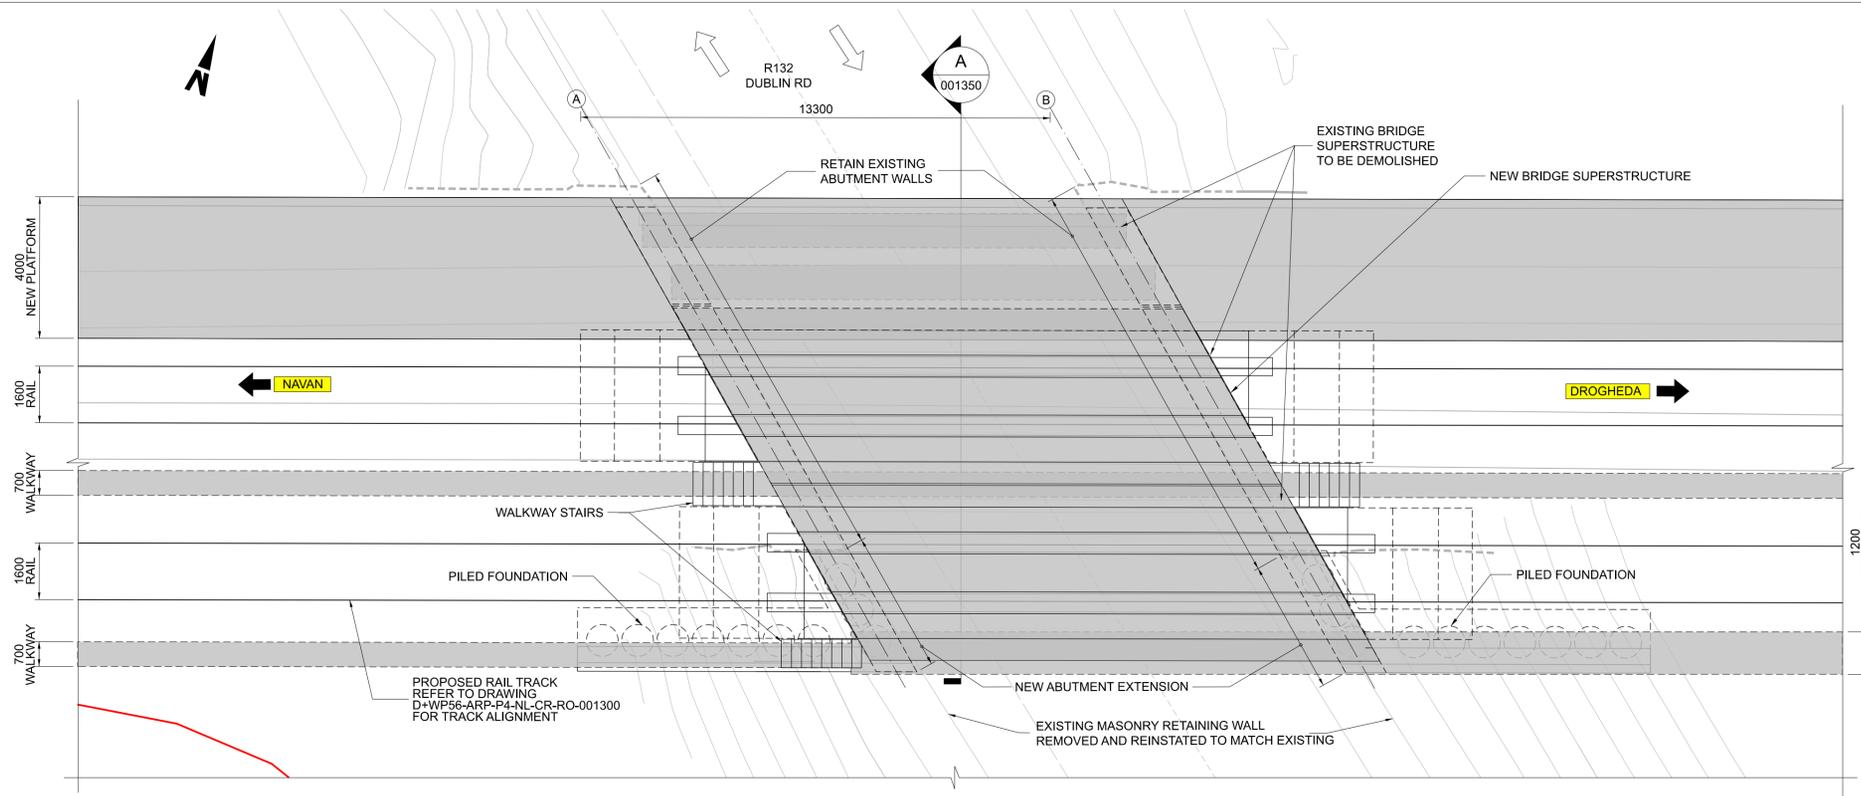

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Rev	Date	Drm	Chk'd	App'd	Description
P01	13/10/2023	WC	CG	DB	PLANNING ISSUE

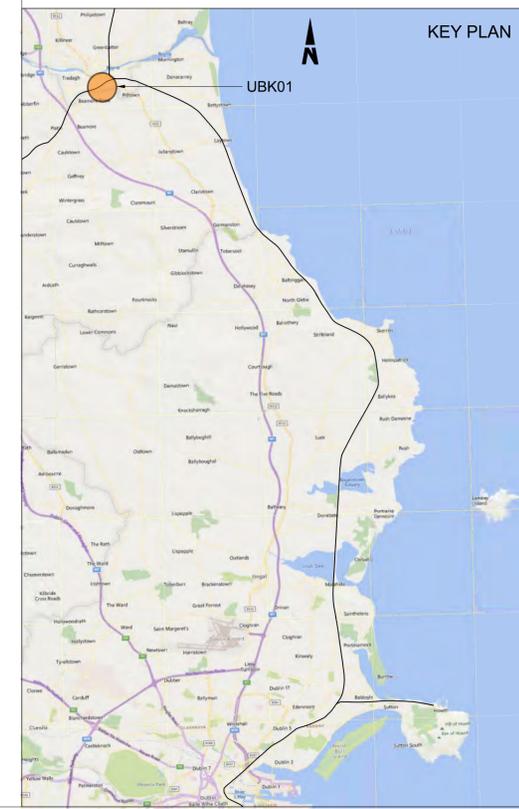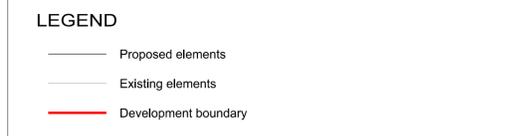Client <b>Iarnród Éireann Irish Rail</b>		Engineering Designer <b>ARUP</b>		
Date 01/06/2023	Scale SHOWN @ A1 @ A3	Drawn WC	Checked CG	Approved DB
Project Code D+WP56	Originator Code ARP	QMS Code 280275-00		


Project Title <b>DART+ COASTAL NORTH</b>				
Drawing Title UBK01 DUBLIN ROAD BRIDGE RECONSTRUCTION GENERAL ARRANGEMENT				
Drawing File Name D+WP56-ARP-P4-NL-DR-RO-001350	Sheet Number 01 of 01	Status S3	Rev P01	

DO NOT SCALE USE FIGURED DIMENSIONS ONLY


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**DROGHEDA MACBRIDE  
STATION**

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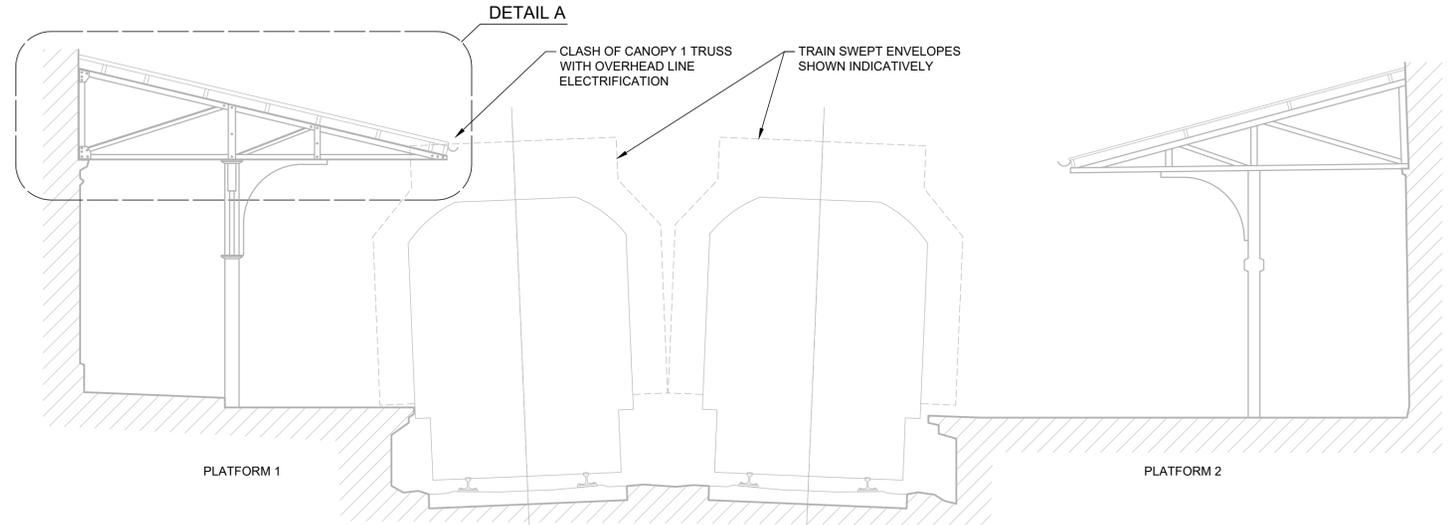
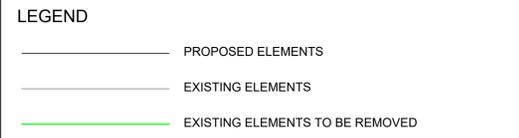


**SITE PLAN**  
SCALE 1:1000

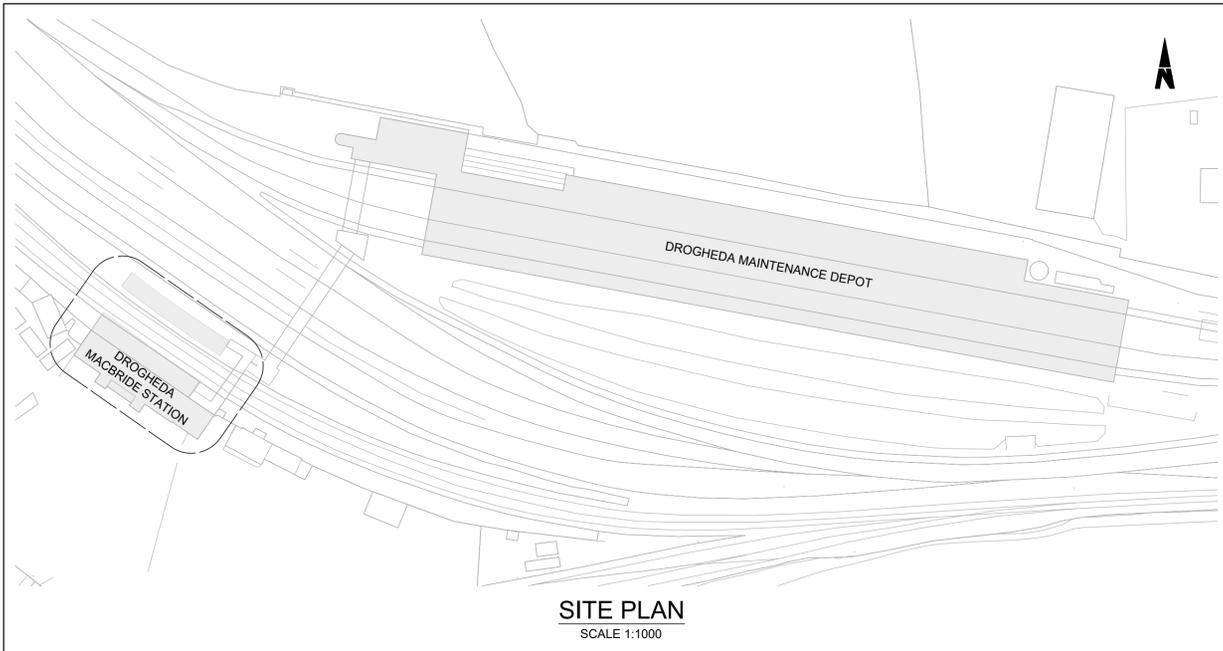


**PLAN ON STATION ROOF CANOPY**  
SCALE 1:200

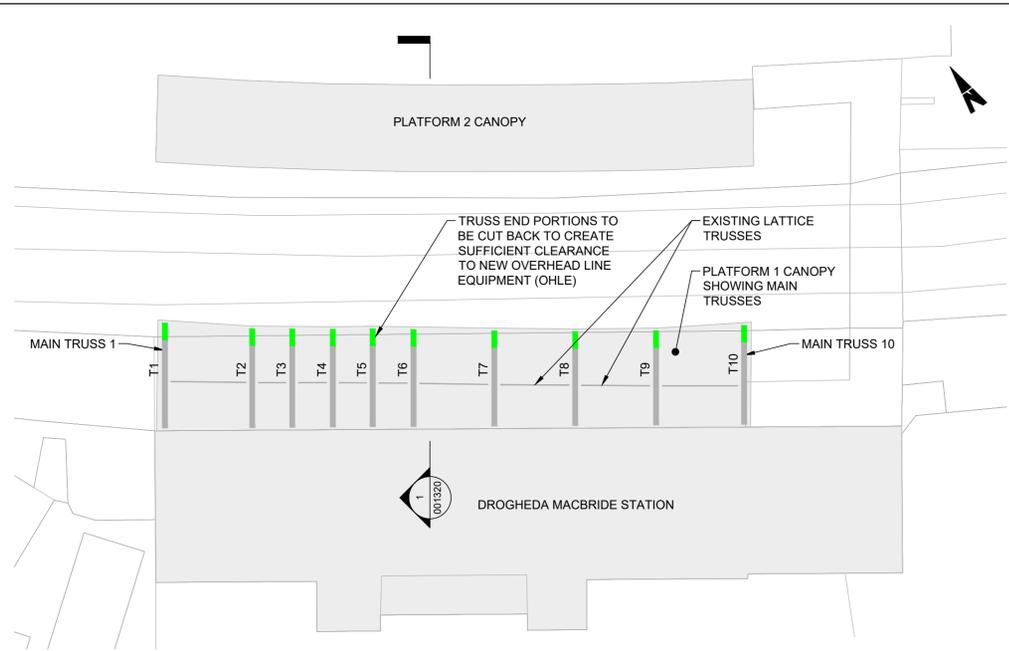
- NOTES**
1. ALL DIMENSIONS ARE SHOWN IN MILLIMETERS UNLESS NOTED OTHERWISE.
  2. ALL LEVELS ARE SHOWN IN METERS ABOVE ORDNANCE DATUM.
  3. DO NOT SCALE FROM THIS DRAWING.
  4. EXTENT OF EACH CANOPY TRUSS TO BE REMOVED WILL BE DETERMINED AT DETAILED DESIGN STAGE ONCE THE OHLE DESIGN IS FINALISED.



**SECTION 1**  
SCALE 1:50

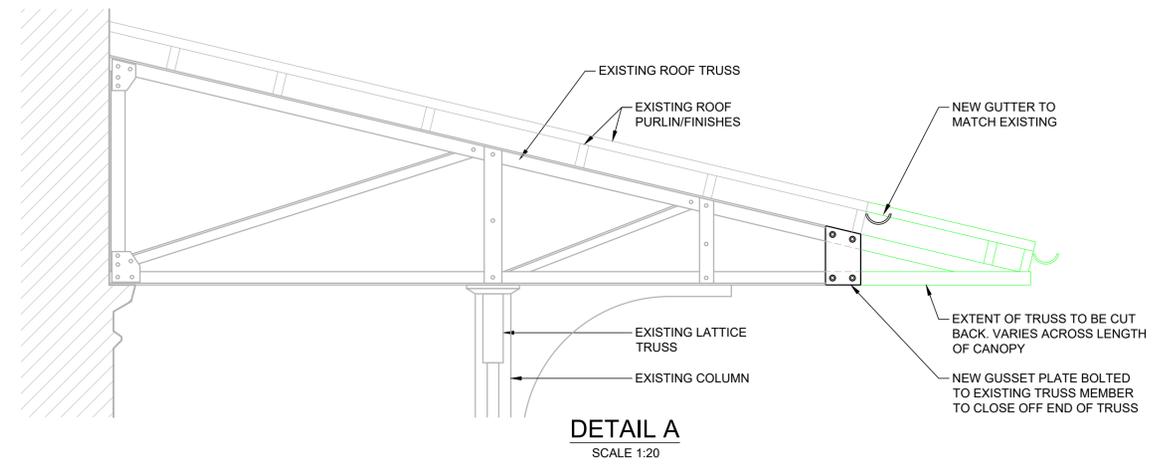

**DETAIL A**  
SCALE 1:20

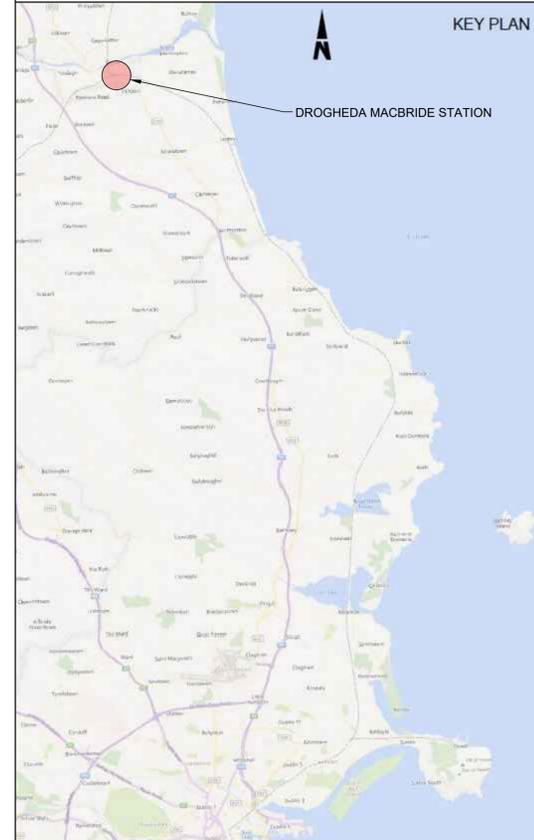

**KEY PLAN**

\\jobath\europa\dublin\jobs\279000\279633-00\Internal\WIP\DE\_Depot\MacBride Station Trusses\D+WP56-ARP-P4-NL-DR-RO-001320.dwg

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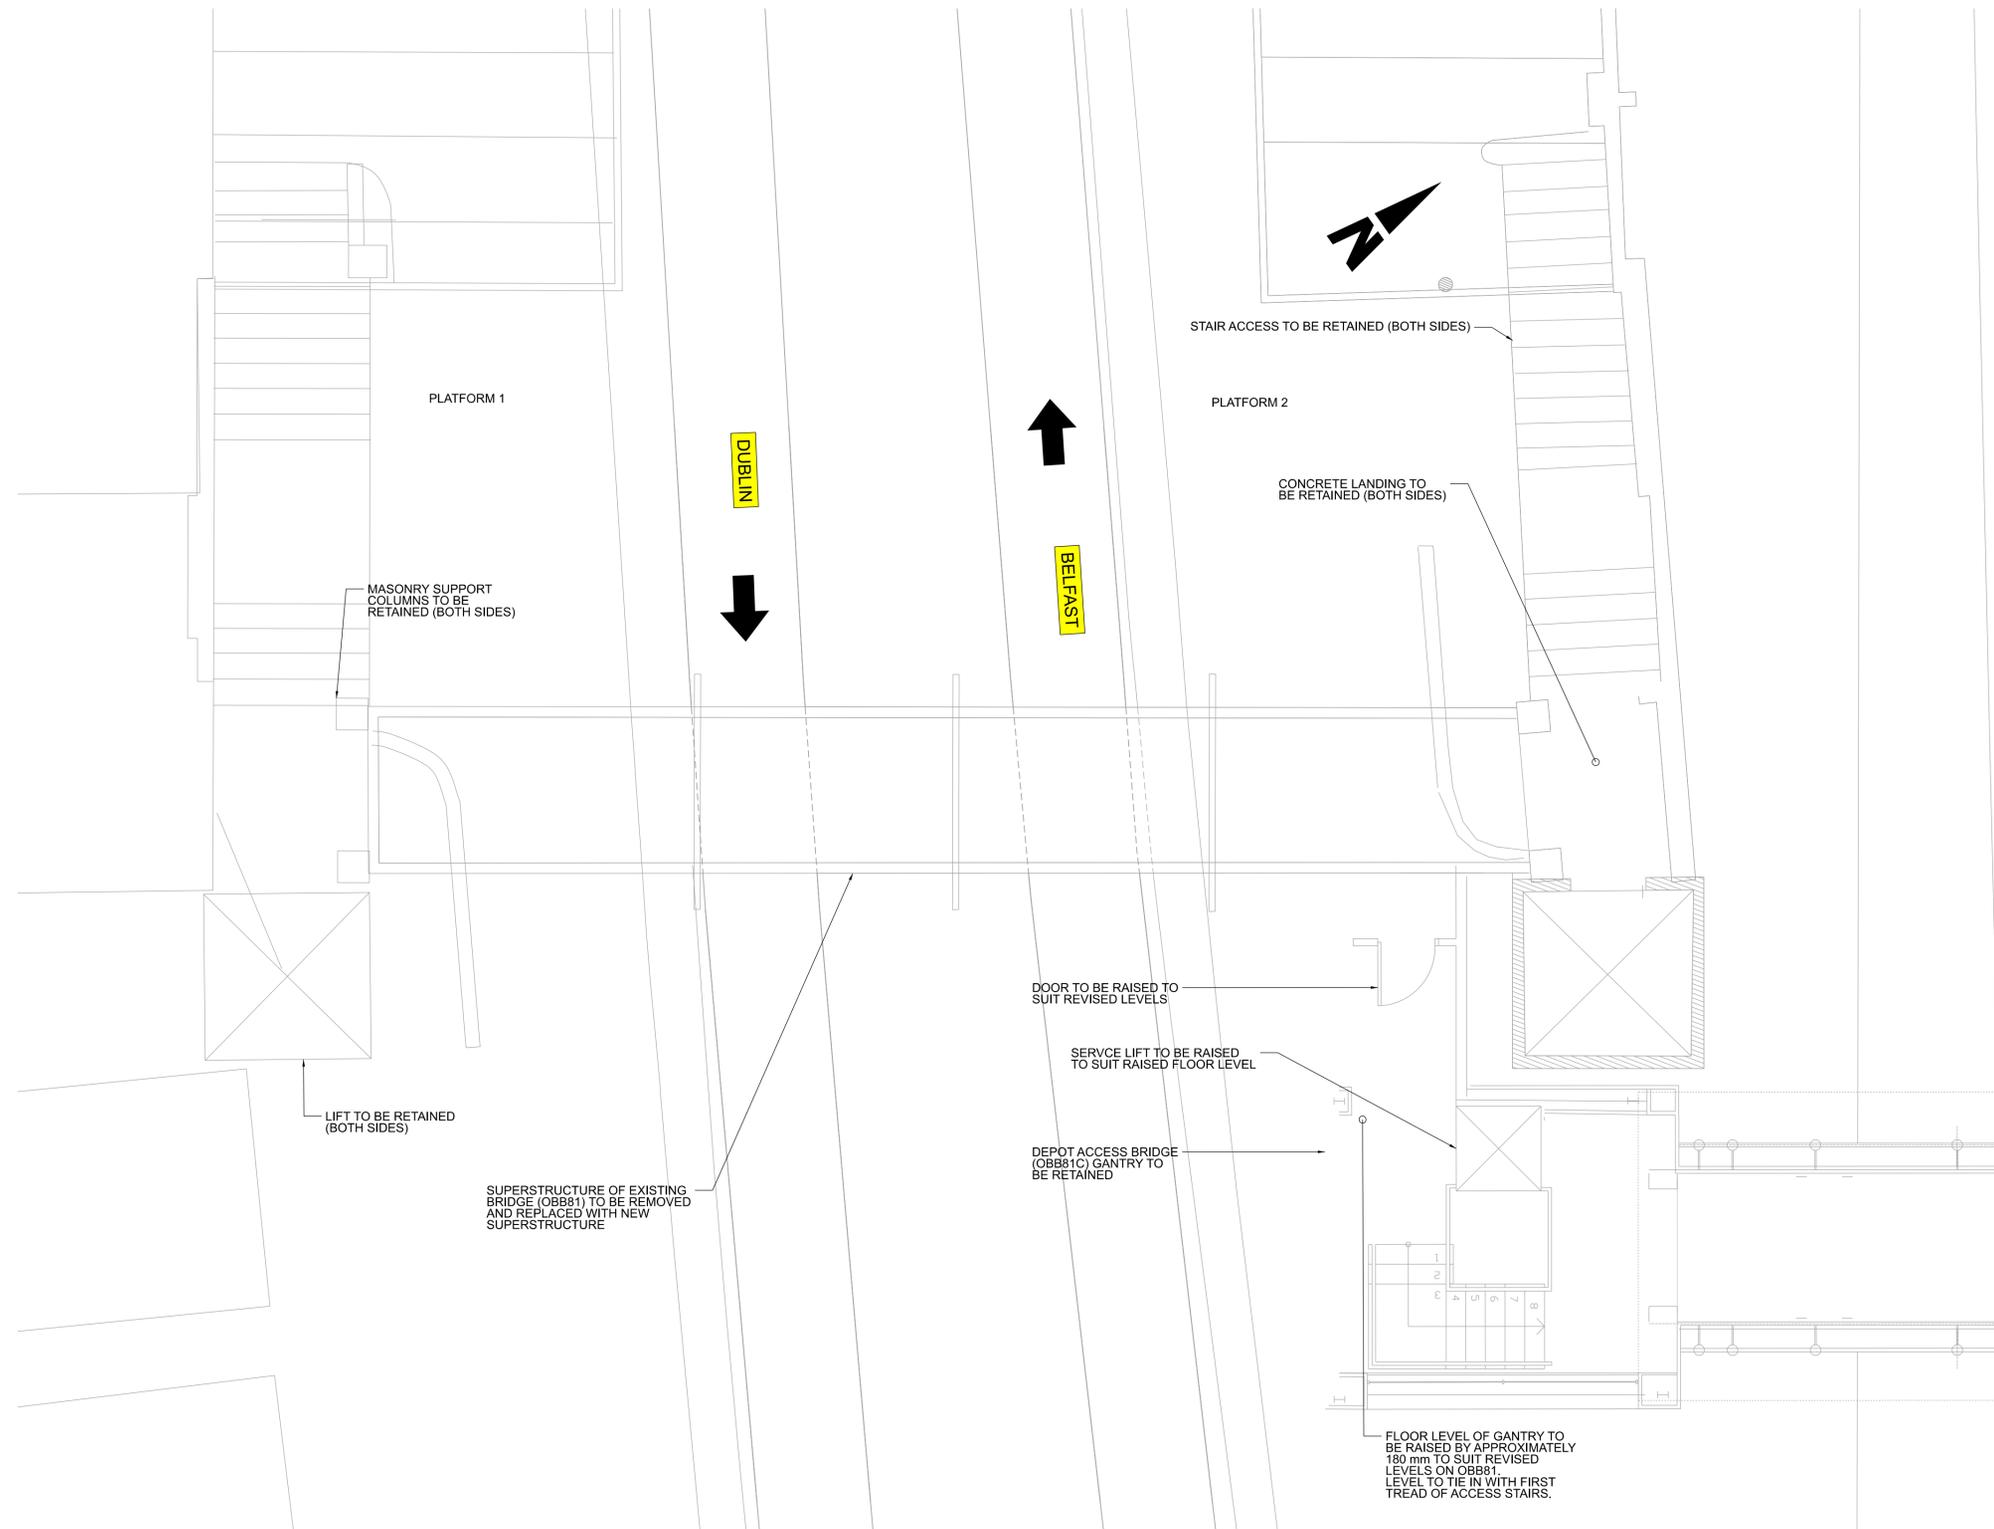
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  	Rev	Date	Drn	Chk'd	App'd	Description
	P01	13/10/2023	GE	SAS	SAS	PLANNING ISSUE

Client 		Engineering Designer 		
Date 01/06/2023	Scale As Shown @ A1 @ A3	Drawn GE	Checked SAS	Approved SAS
Project Code D+WP56	Originator Code ARP	QMS Code 279933-00		

Project Title <b>DART+ COASTAL NORTH</b>			
Drawing Title DROGHEDA MACBRIDE STATION PLATFORM 1 CANOPY MODIFICATIONS GENERAL ARRANGEMENT			
Drawing File Name D+WP56-ARP-P4-NL-DR-RO-001320	Sheet Number 01 of 01	Status S3	Rev P01


DO NOT SCALE USE FIGURED DIMENSIONS ONLY



EXISTING PLAN VIEW  
001340 1:50

- NOTES**
1. ALL DIMENSIONS ARE SHOWN IN MILLIMETERS UNLESS NOTED OTHERWISE.
  2. ALL LEVELS ARE SHOWN IN METERS ABOVE ORDINANCE DATUM.
  3. DO NOT SCALE FROM THIS DRAWING.
  4. ALL STRUCTURAL STEELWORK SHALL BE DUPLEX STAINLESS STEEL GRADE EN 1.4162.
  5. ALL STAINLESS STEEL BOLT AND SCREW CONNECTIONS SHALL BE GRADE A4-70.
  6. PROPOSED AND EXISTING OVERHEAD LINE EQUIPMENT (OHLE) IS NOT SHOWN IN PLAN OR ELEVATION.
  7. REFER TO BOOK 7 LINEAR WORKS PLANS FOR OHLE AND LINESIDE CIVILS ELEMENTS SHOWN IN PLAN.

- LEGEND**
- PROPOSED ELEMENTS
  - EXISTING ELEMENTS

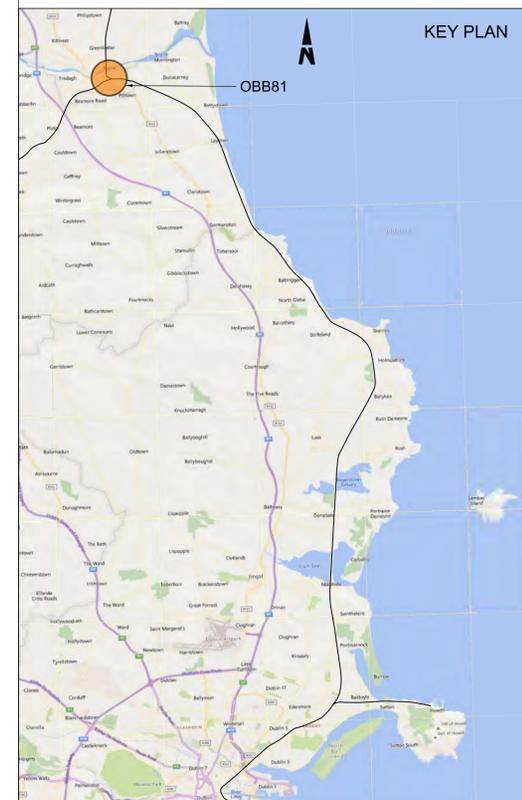

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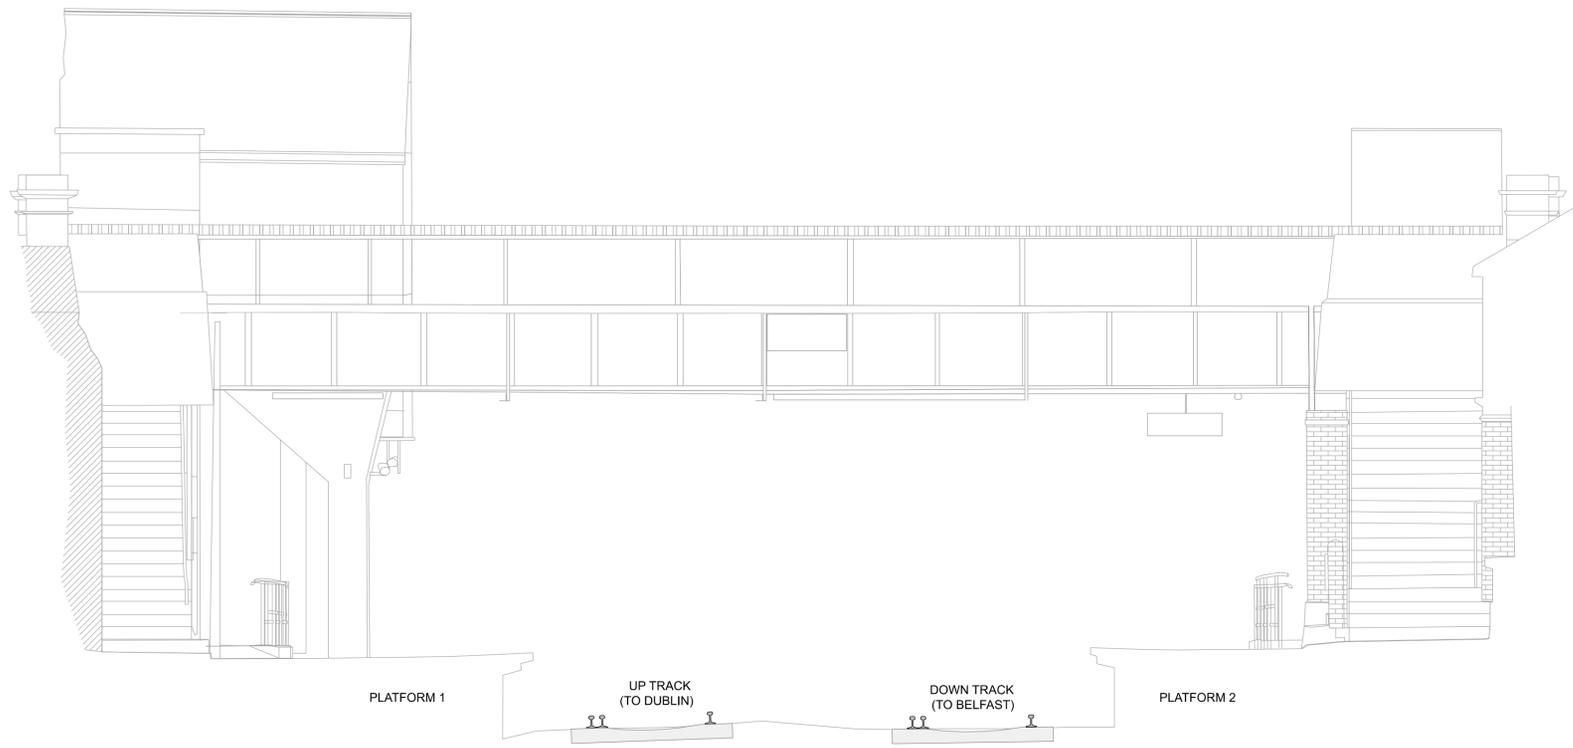


Rev	Date	Dwn	Chk'd	App'd	Description
P01	13/10/2023	SF	CG	DB	PLANNING ISSUE


Client <b>Iarnród Éireann Irish Rail</b>		Engineering Designer <b>ARUP</b>		
Date 01/06/2023	Scale @ A1 AS SHOWN @ A3	Drawn SF	Checked CG	Approved DB
Project Code D+WP56	Originator Code ARP	QMS Code 280275-00		

Project Title <b>DART+ COASTAL NORTH</b>			
Drawing Title <b>OBB81 - DROGHEDA STATION FOOTBRIDGE GENERAL ARRANGEMENT</b>			
Drawing File Name D+WP56-ARP-P4-NL-DR-RO-001340	Sheet Number 01 of 02	Status S3	Rev P01


DO NOT SCALE USE FIGURED DIMENSIONS ONLY



**NORTH ELEVATION - EXISTING**  
001341 1:50


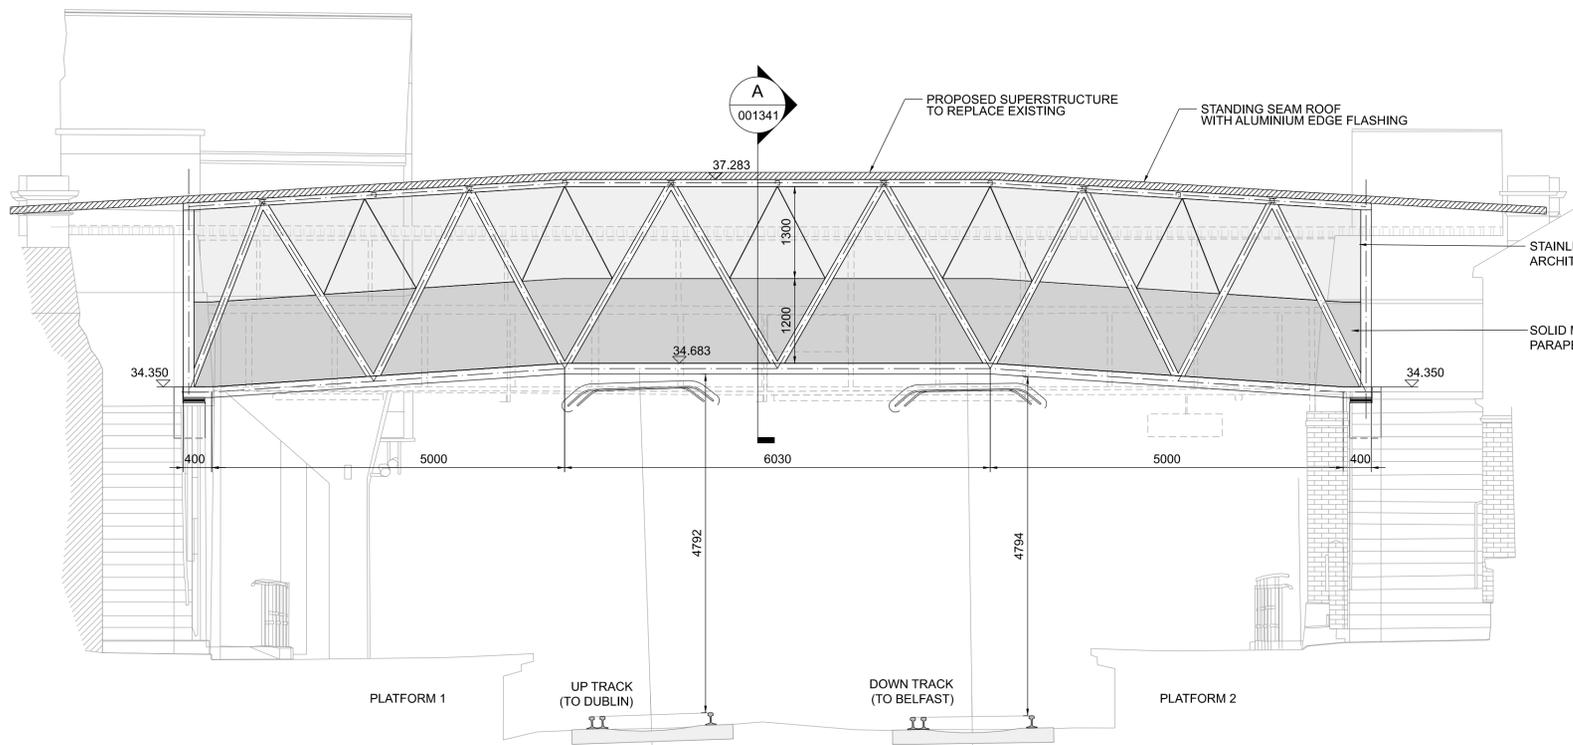


**NORTH ELEVATION - PROPOSED**  
001341 1:50

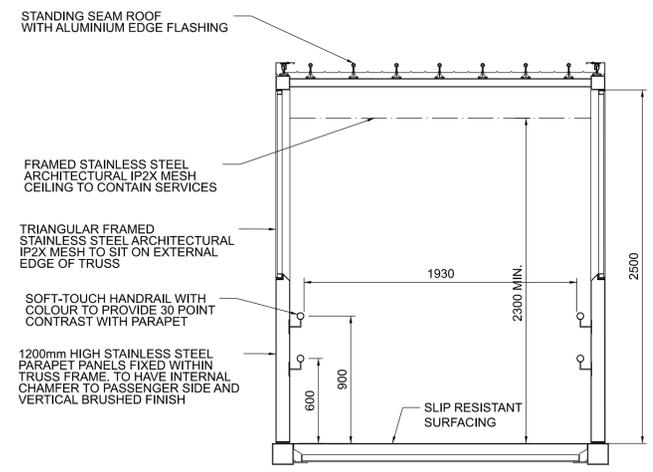

**SECTION A**  
001341 1:25

- NOTES:**
- ALL DIMENSIONS ARE SHOWN IN MILLIMETERS UNLESS NOTED OTHERWISE.
  - ALL LEVELS ARE SHOWN IN METERS ABOVE ORDINANCE DATUM.
  - DO NOT SCALE FROM THIS DRAWING.
  - ALL STRUCTURAL STEELWORK SHALL BE DUPLEX STAINLESS STEEL GRADE EN 1.4162.
  - ALL STAINLESS STEEL BOLT AND SCREW CONNECTIONS SHALL BE GRADE A4-70.

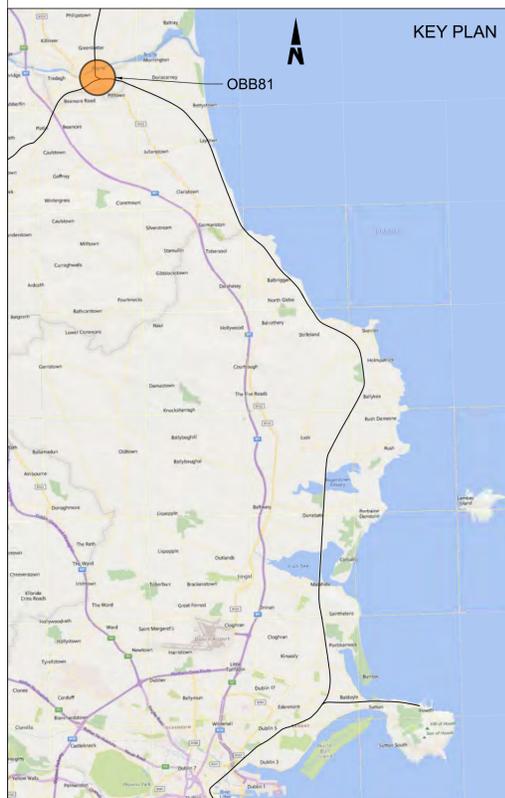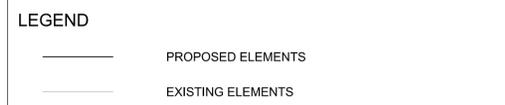

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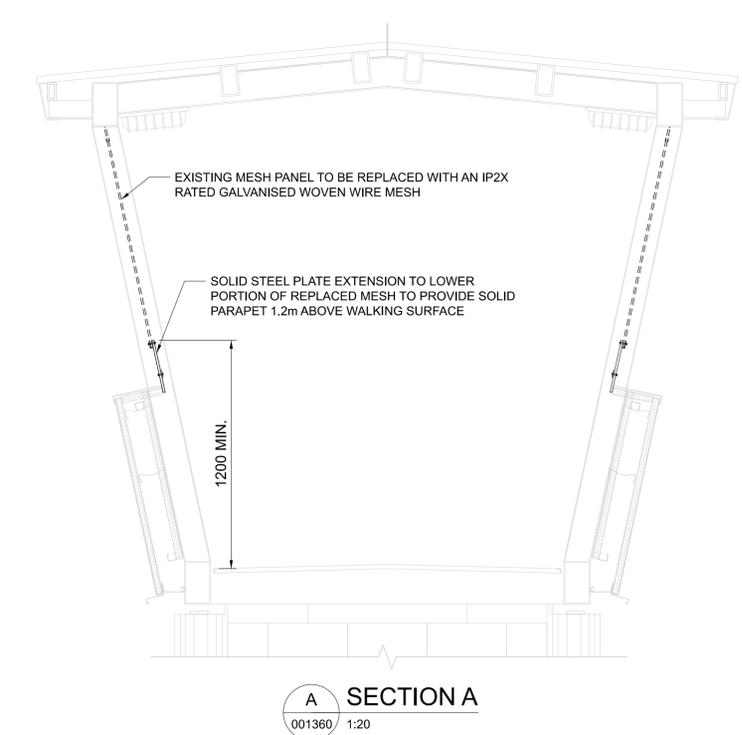
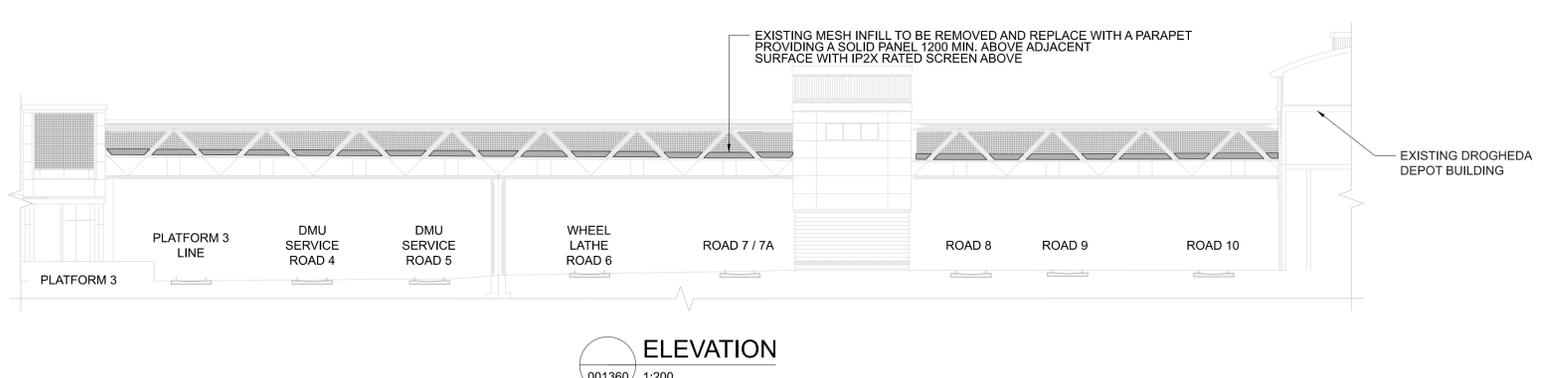
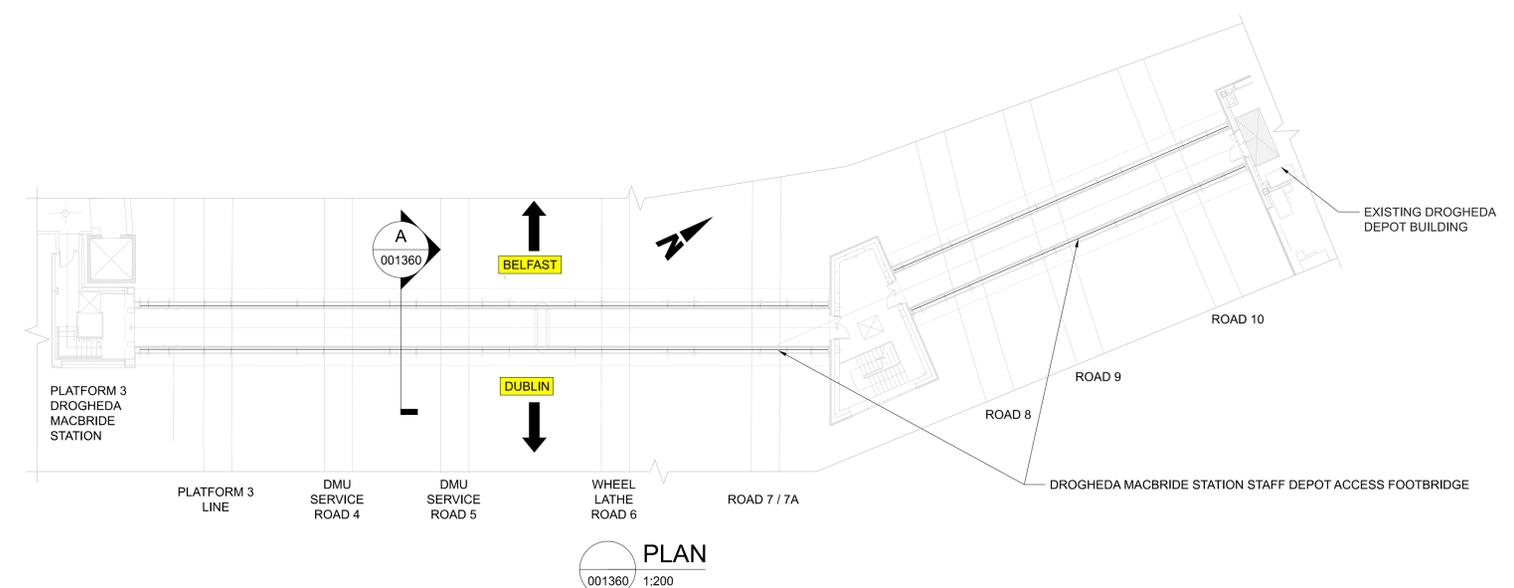


Rev	Date	Dm	Chk'd	App'd	Description
P01	13/10/2023	SF	CG	DB	PLANNING ISSUE



Client <b>Iarnród Éireann Irish Rail</b>		Engineering Designer <b>ARUP</b>		
Date 01/06/2023	Scale @ A1 AS SHOWN @ A3	Drawn SF	Checked CG	Approved DB
Project Code D+WP56	Originator Code ARP	QMS Code 280275-00		

Project Title <b>DART+ COASTAL NORTH</b>			
Drawing Title <b>OBB81 - DROGHEDA STATION FOOTBRIDGE ELEVATIONS</b>			
Drawing File Name D+WP56-ARP-P4-NL-DR-RO-001341	Sheet Number 02 of 02	Status S3	Rev P01

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  2. ALL LEVELS ARE SHOWN IN METERS ABOVE ORDINANCE DATUM.
  3. DO NOT SCALE FROM THIS DRAWING.
  4. ALL STEELWORK SHALL BE GRADE S355 UNLESS NOTED OTHERWISE. STEELWORK SHALL CONFORM TO THE FOLLOWING STANDARDS:  
UB & UC SECTIONS - BS EN 10025  
PFC & PLATES - BS EN 10025  
RHS, SHS & CHS - BS EN 10210  
EQUAL & UNEQUAL ANGLES - BS EN 10056  
FLAT, SQUARE & ROUND BAR - BS EN 10025
  5. ALL WELDED CONNECTIONS SHALL BE GRADE S355 UNLESS NOTED OTHERWISE.
  6. ALL BOLT ASSEMBLIES SHALL BE OF PROPERTY CLASS 8.8 UNLESS NOTED OTHERWISE, WITH HEXAGONAL HEADED BOLTS CONFORMING TO BS EN 4014, NUTS TO BS EN 4032 AND HIGH STRENGTH STEEL WASHERS TO BS EN 7091.
  7. ALL STEELWORK SHALL BE HOT DIP GALVANISED IN ACCORDANCE WITH IS EN ISO 1461.
  8. PROPOSED AND EXISTING OVERHEAD LINE EQUIPMENT (OHLE) IS NOT SHOWN IN PLAN OR ELEVATION.



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Rev	Date	Dm	Chk'd	App'd	Description
P01	13/10/2023	WC	CG	DB	PLANNING ISSUE

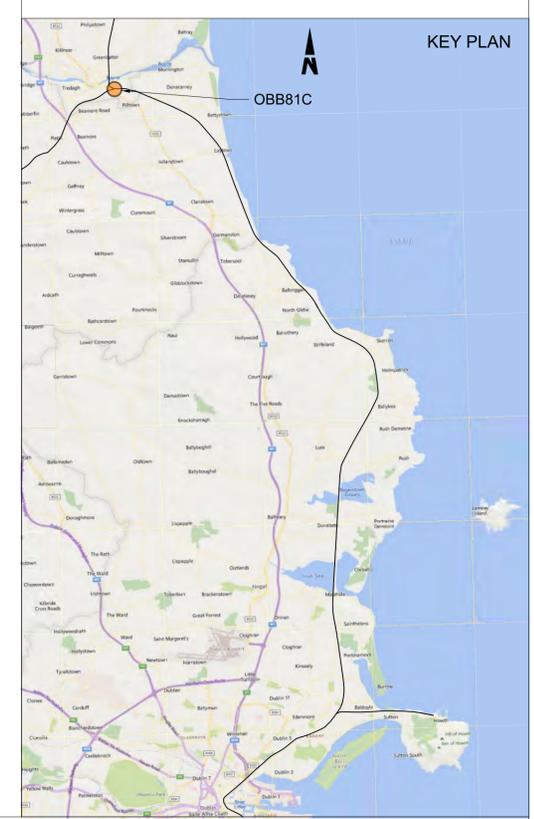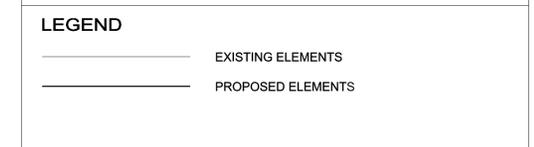Client: **Iarnród Éireann Irish Rail**

Engineering Designer: **ARUP**

Date: 01/06/2023 | Scale: As Shown @ A1 @ A3

Project Code: D+WP56 | Originator Code: ARP

Drawn: AS | Checked: CG | Approved: DB

QMS Code: 280275-00

Project Title: <b>DART+ COASTAL NORTH</b>			
Drawing Title: <b>OBB81C DROGHEDA DEPOT STAFF ACCESS FOOTBRIDGE PARAPET MODIFICATIONS GENERAL ARRANGEMENT</b>			
Drawing File Name: <b>D+WP56-ARP-P4-NL-DR-RO-001360</b>	Sheet Number: <b>01 of 01</b>	Status: <b>S3</b>	Rev: <b>P01</b>

DO NOT SCALE USE FIGURED DIMENSIONS ONLY